

DEVELOPMENT REVIEW HEARING PROJECT OVERVIEW

Meeting Date: July 29, 2020

File No.(s): **PLN2020-14453**

Location: 2317 Glendenning Avenue, a 6,666 square-foot site located at the

northwest corner of Glendenning Avenue and Los Padres Boulevard;

APN: 303-05-010; property is zoned Single-Family Residential

(R1-6L).

Applicant: Leopold Design
Owner: Katy and Jesse Kerns

Request: Architectural Review of the proposed interior remodel and 446

square-foot second floor expansion to an existing 2,259 square-foot three-bedroom, two-bathroom two-story home resulting in a 2,705 square-foot four-bedroom, three-bathroom two-story single-family

residence with an attached two-car garage to remain.

Mailing Radius: 300 feet

CEQA Determination: Categorical Exemption per CEQA 15301(e)(1), Existing Facilities

Project Planner: Jeff Schwilk, Associate Planner Staff Recommendation: Approve, subject to conditions

Project Data

Lot Size: 6,666 sq. ft.			
	Existing Floor Area (sq. ft.)	Proposed New Building (sq. ft.)	Proposed Floor Area (sq.ft.)
First Floor	1,594	-	1,594
Second Floor	215	446	661
Porch cover	0	42	42
Garage	450	-	450
Sheds	0	0	0
Gross Floor Area	2,259		2,705
Lot Coverage	2,044/6,666 = 31%		2,086/6,666 = 31%
F.A.R.	2,259/6,666 = .34		2,705/6,666 = .41
% of 2 nd floor to 1 st floor	n/a		661/2,044 = 32%
Bedrooms/Baths	3/2	1/2	4/3
Flood Zone	X		

Points for consideration

- The existing house was constructed in 1953 by developer David Bohannon. A second floor family room addition with vaulted ceiling area was added at a later date.
- The project includes the remodel and partial reconfiguration of the ground floor, combining two
 bedrooms into one bedroom, and the remodel and 446 square foot expansion to the existing 215
 square foot second floor, reconfiguring and enlarging the second floor from the current family
 room into two new bedrooms and a new bathroom.
- Overall building height would decrease from the existing height of 23-feet, 4-inches to proposed height of 21-feet, 8-inches.
- 300-foot neighborhood notice was distributed for this project review.

Development Review Hearing Address: 2317 Glendenning Avenue

July 29, 2020 Page 2

There are no active code enforcement cases for this property.

Findings supporting the Staff Recommendation

- 1) That any off-street parking area, screening strips and other facilitates and improvements necessary to secure the purpose and intent of this title and the general plan of the City area a part of the proposed development, in that;
 - The proposal provides the required two covered parking spaces.
 - The required parking spaces are not located in the required front yard or street side yard landscaped areas.
 - The proposed project provides areas surfaced with all-weather materials for parking of vehicles.
- 2) That the design and location of the proposed development and its relation to neighboring developments and traffic is such that it will not impair the desirability of investment or occupation in the neighborhood, will not unreasonably interfere with the use and enjoyment of neighboring developments, and will not create traffic congestion or hazard, in that;
 - The proposed house remodel and expansion resulting in one additional bedroom and one additional bathroom would not create traffic congestion or hazards.
 - Public streets are adequate in size and design to serve the proposed single-family residence, and the use will not create a substantive increase in traffic.
- 3) That the design and location of the proposed development is such that it is in keeping with the character of the neighborhood and is such as not to be detrimental to the harmonious development contemplated by this title and the general plan of the City, in that;
 - The proposed development is a slightly enlarged two-story home that is consistent with the scale and design similar to that of the existing surrounding neighborhood.
- 4) That the granting of such approval will not, under the circumstances of the particular case, materially affect adversely the health, comfort or general welfare of persons residing or working in the neighborhood of said development, and will not be materially detrimental to the public welfare or injuries to property or improvements in said neighborhood, in that;
 - The project is subject to the California Building Code and City Code requirements, which serve to regulate new construction to protect public health, safety and general welfare.
- 5) That the proposed development, as set forth in the plans and drawings, are consistent with the set of more detailed policies and criteria for architectural review as approved and updated from time to time by the City Council, which set shall be maintained in the planning division office. The policies and criteria so approved shall be fully effective and operative to the same extent as if written into and made a part of this title, in that;
 - The project would create a house design that is compatible scale and character with the housing types that are typical in the neighborhood.


Conditions of Approval:

- 1) Garage or carport shall be maintained clear and free for vehicle parking use at all times. It shall not be used only for storage.
- 2) Submit plans for final architectural review to the Planning Division for approval prior to issuance of building permits. Said plans to include, but not be limited to: site plans, floor plans, elevations, landscaping, lighting and signage.

Development Review Hearing Address: 2317 Glendenning Avenue

July 29, 2020 Page 3

- 3) Landscaping installation shall meet City water conservation criteria in a manner acceptable to the Director of Community Development.
- 4) Rehabilitate the front yard landscaping between the fence and sidewalk. New landscape areas of 500 square feet or more or rehabilitated landscape areas of 2,500 square feet or more shall conform to the California Department of Water Resources Water Efficient Landscape Ordinance.
- 5) Developer/Owner is responsible for collection and pick-up of all trash and debris on-site and adjacent public right-of-way.
- 6) Construction activity shall be limited to the hours of 7:00 a.m. to 6:00 p.m. weekdays and 9:00 a.m. to 6:00 p.m. Saturdays for projects within 300 feet of a residential use and shall not be allowed on recognized State and Federal holidays.
- 7) Incorporate Best Management Practices (BMPs) into construction plans and incorporate post construction water runoff measures into project plans in accordance with the City's Urban Runoff Pollution Prevention Program standards prior to the issuance of permits.

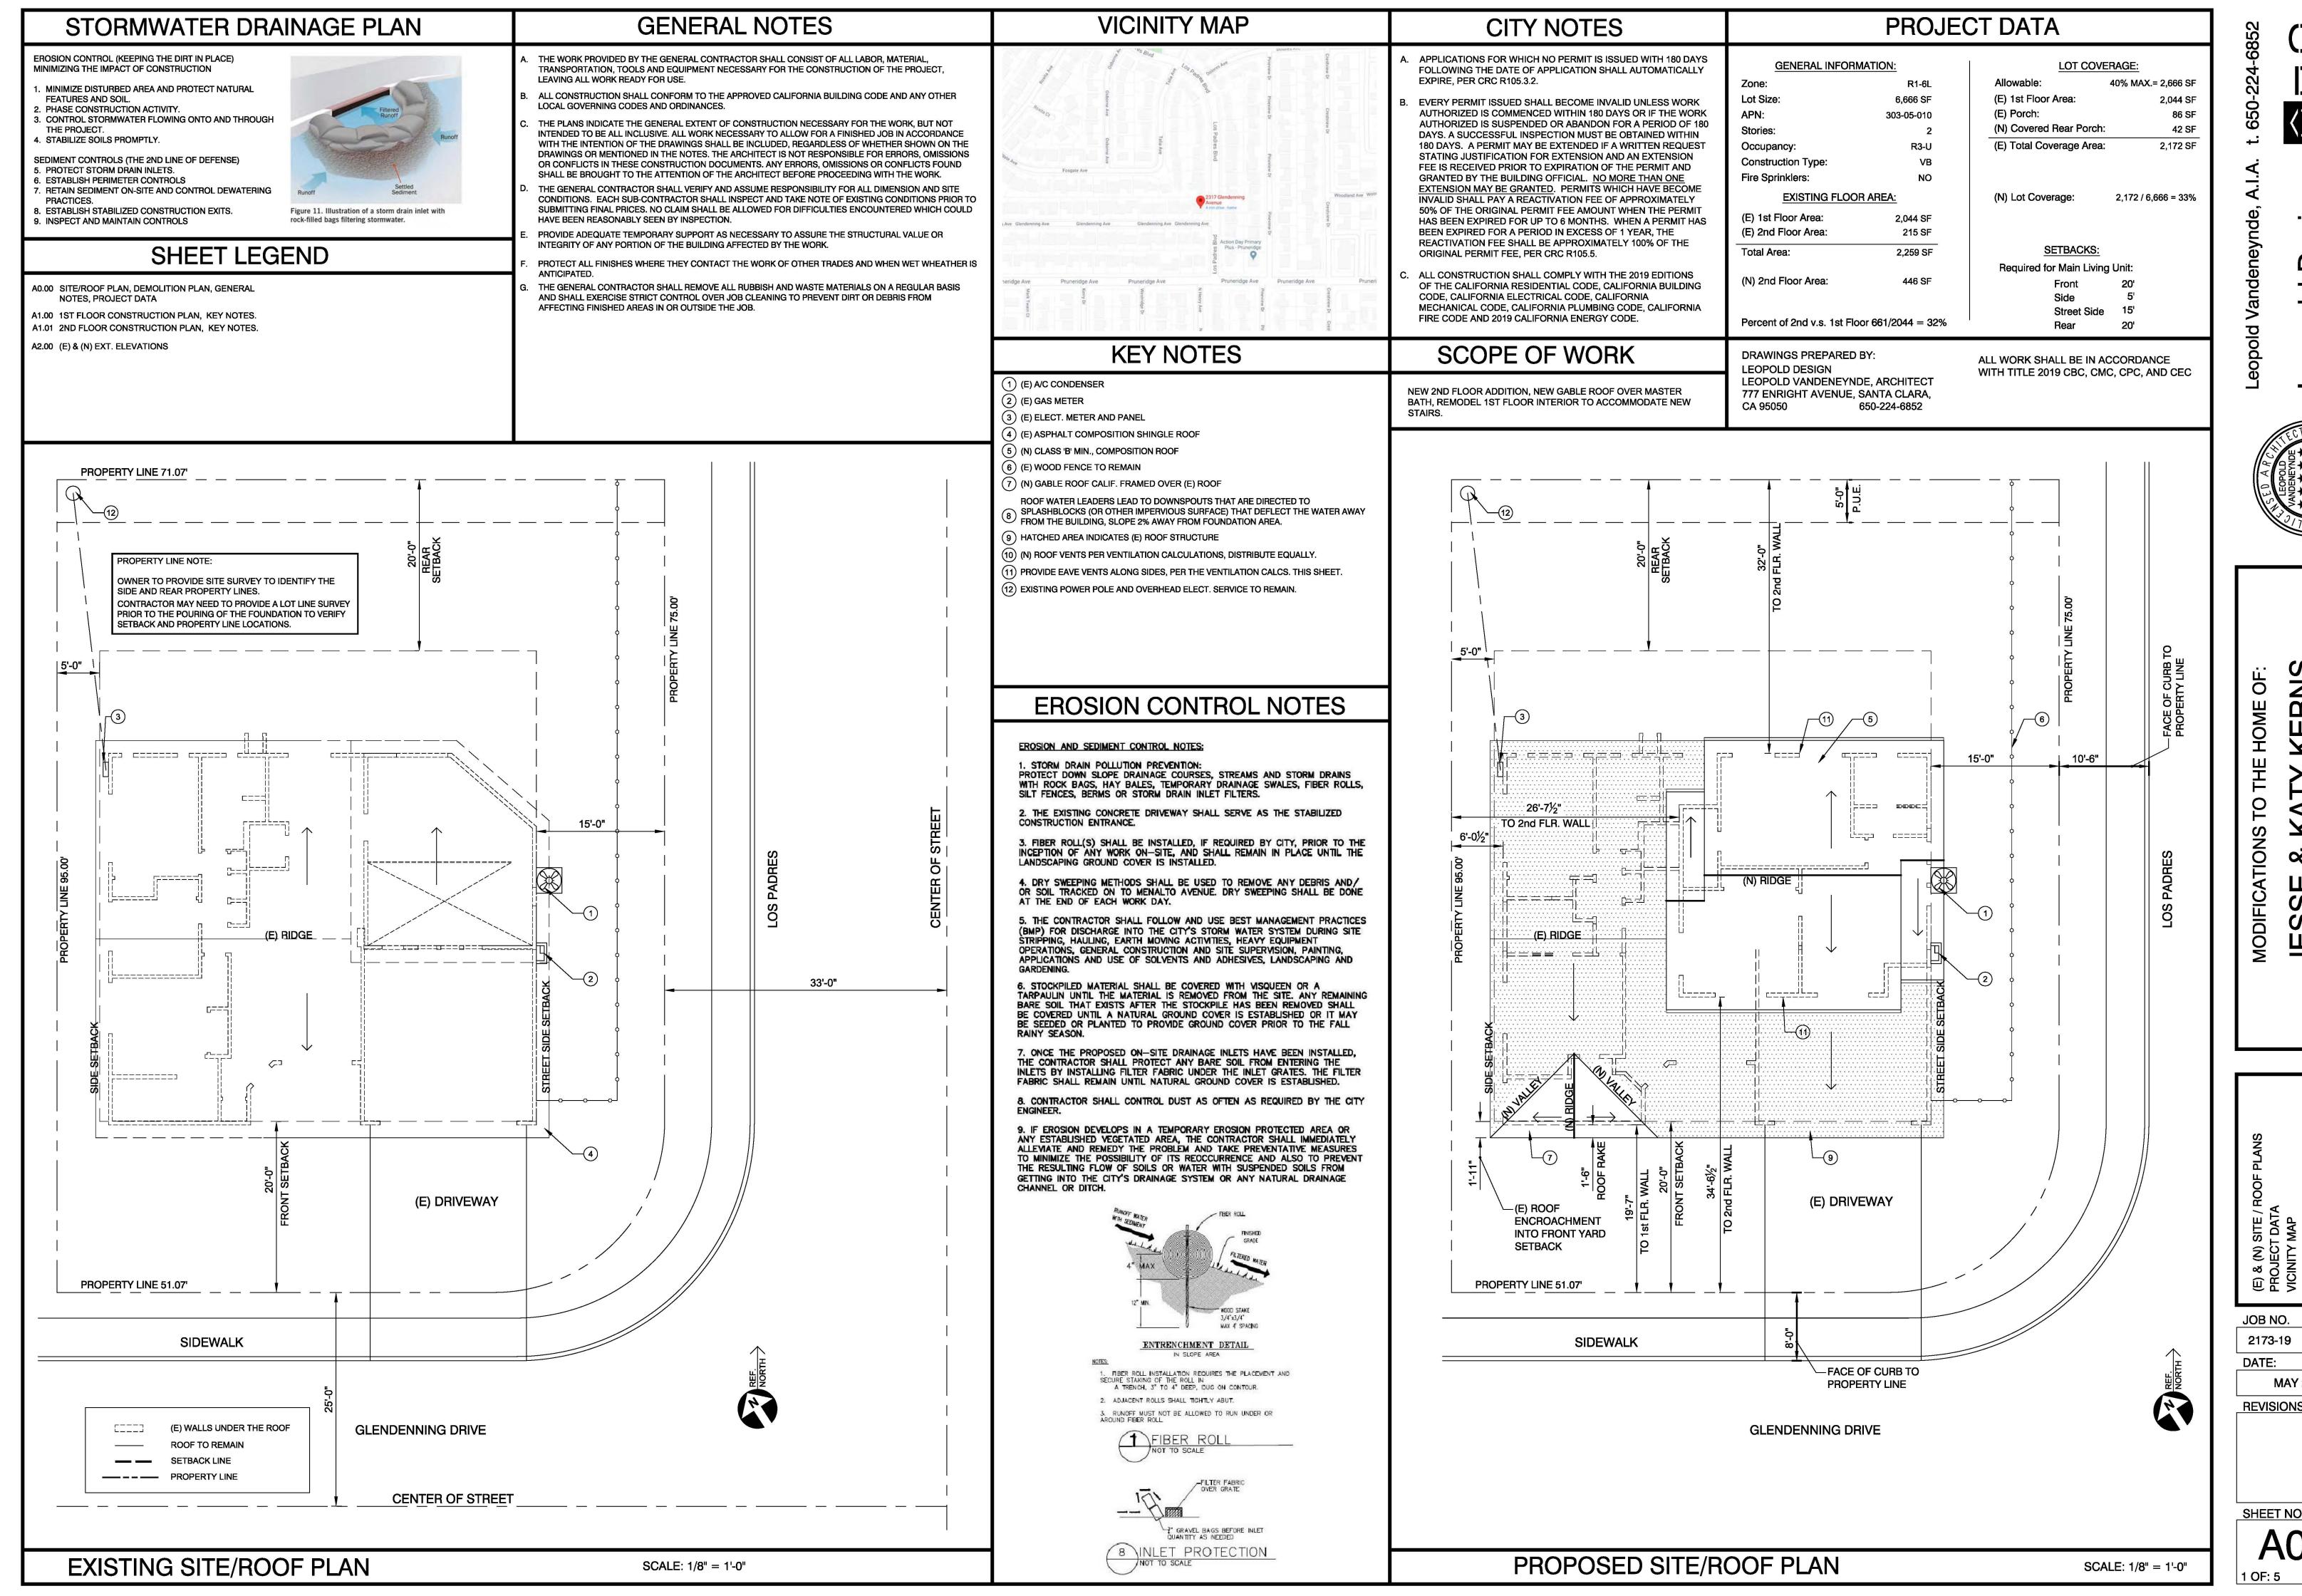

DRAWN BY

MAY 22, 2020



(1) WOOD TREADS AND PAINTED RISERS

HANDRAILS SHALL NOT PROJECT MORE THAN 4.5" ON EITHER SIDE OF THE STAIRWAY & THE MIN. CLEAR WIDTH OF THE STAIRWAY AT & BELOW THE HANDRAIL HEIGHT, INCLUDING TREADS & LANDINGS, SHALL NOT BE LESS THAN 31.5" WHERE A HANDRAIL IS INSTALLED ON ONE SIDE AND 27" WHERE HANDRAILS ARE PROVIDED ON BOTH SIDES. HANDRAILS SHALL BE PROVIDED ON AT LEAST ONE SIDE OF EACH CONTINUOUS RUN OF TREADS OR FLIGHT WITH FOUR OR MORE RISERS. HANDRAIL HEIGHT, MEASURED VERTICALLY FROM THE SLOPED PLANE ADJOINING THE TREAD NOSING, OR FINISH SURFACE OF RAMP SLOPE, SHALL BE NOT LESS THAN 34" AND NOT MORE THAN 38". HANDRAIL ENDS SHALL BE RETURNED OR SHALL TERMINATE IN NEWEL POSTS OR

TYPE I. HANDRAILS W/ A CIRCULAR CROSS SECTION SHALL HAVE AN OUTSIDE DIAMETER OF AT LEAST 1.25" & NOT GREATER THAN 2". IF THE HANDRAIL IS NOT CIRCULAR, IT SHALL HAVE A PERIMETER DIMENSION OF AT LEAST 4 INCHES AND NOT GREATER THAN 6,25" W/ A MAX. CROSS SECTION OF DIMENSION OF 2.25". EDGES

TYPE II. HANDRAILS W/ A PERIMETER GREATER THAN 6.25" SHALL HAVE A GRASPABLE FINGER RECESS AREA ON BOTH SIDES OF THE PROFILE. THE FINGER RECESS SHALL BEGIN WITHIN A DISTANCE OF 0.75" MEASURED VERTICALLY FROM THE TALLEST PORTION OF THE PROFILE AND ACHIEVE A DEPTH OF AT LEAST 5/1" WITHIN 7/8" BELOW THE WIDEST PORTION OF THE PROFILE. THIS REQUIRED DEPTH SHALL CONTINUE FOR AT LEAST 3/8" TO A LEVEL THAT IS NOT LESS THAN 1.75" BELOW THE TALLEST PORTION OF THE PROFILE. THE MIN. WIDTH OF THE HANDRAIL ABOVE THE RECESS SHALL BE 1.25" TO A MAX. OF 2.75". EDGES SHALL HAVE

CAL GREEN NOTES

A. AUTOMATIC IRRIGATION SYSTEMS CONTROLLERS INSTALLED AT THE TIME OF FINAL INSPECTION SHALL

B. PROTECT ANNULAR SPACES AROUND PIPES, ELECTRIC CABLES, CONDUITS OR OTHER OPENINGS AT EXTERIOR WALLS AGAINST THE PASSAGE OF

AIR DISTRIBUTION COMPONENT OPENINGS DURING

COMPLIANT WITH PRODUCT WEIGHTED MIR LIMITS FOR ROC AND OTHER TOXIC COMPOUNDS (4.504.2.3) VERIFICATION OF COMPLIANCE SHALL BE PROVIDED

GENERATED AT THE SITE SHALL BE DIVERTED TO AN OFF-SITE RECYCLE, DIVERSION, OR SALVAGE

REQUEST OF THE BUILDING DIVISION, TO VERIFY COMPLIANCE WITH VOC FINISH MATERIALS.

(MDF) AND HARDWOOD PLYWOOD USDED IN INTERIOR FINISH SYSTEMS SHALL COMPLY WITH LOW FORMALDEHYDE EMISSION STANDARDS 4.504.5

AND CERTIFIED IN THE PROPER INSTALLATION OF HVAC SYSTEMS AND EQUIPMENT BY A RECOGNIZE TRAINING OR CERTIFICATION PROGRAM (702.1)

MATERIALS USED IN WALL AND FLOOR FRAMING

WITH THIS CODE MAY INCLUDE CONSTRUCTION DOCUMENTS, PLANS, SPECIFICATIONS, BUILDER OR INSTALLER CERTIFICATION, INSPECTION REPORTS, OR OTHER METHODS ACCEPTABLE TO THE BUILDING DEPARTMENT WHICH WILL SHOW SUBSTANTIAL

M. FOUNDATION MIX SHALL INCORPORATE 20% REDUCTION IN CEMENT USE. CONCRETE TO CONSIST

DIMENSION POINT TO CENTER OF

2 EXISTING GAS METER

REFER TO HANDRAIL NOTE THIS SHEET

TYPE-X FIRE RATED GYPBD. AT GARAGE WALLS AND CEILING (IF 2ND FLOOR AREA IS DIRECTLY ABOVE.)

(N) 22" MIN. BY 30" MIN. ATTIC ACCESS TO SPACES WITH 30"

PROVIDE 1/2" GYP.BD. UNDER ENTIRE LENGTH OF STAIR & SOFFIT OF ENCLOSED USABLE SPACE. CRC R302.7.

(6) CLEAR HEIGHT OR MORE. PROVIDE ACCESS OPENING

THROUGH (E) ROOF AT CALIF. FRAMED AREA.

(N) SOLID CORE DOOR WITH SELF CLOSURE DEVICE AND (N) SOLID SOLIL GASKETED JAMBS.

(N) 22" MIN. BY 30" MIN. ATTIC ACCESS TO SPACES WITH 30" (9) CLEAR HEIGHT OR MORE. PROVIDE ACCESS OPENING THROUGH (E) ROOF AT CALIF. FRAMED AREA.

WATER CLOSETS TO HAVE A MIN. CLEAR STALL SPACES OF 30" & A MINIMUM CLEAR SPACE OF 24" IN FRONT & 1.28 GALLONS PER FLUSH MAX. SHOWER HEADS W/ A FLOW RATE GREATER THAN 2.5 GPM WILL NEED TO BE REPLACED W/ A MXIMUM 2.0 GPM SHOWER HEAD. LAVATORY & KITCHEN FAUCETS W/ A FLOW RATE GREATER THAN 2.2 GPM WILL NEED TO BE REPLACED W/ A FAUCET W/ MAX. FLOW RATE OF

MAINTAIN MIN. 6'-8" HEADROOM CLEARANCE THE FULL LENGTH OF STAIR. - RISERS ON STAIRWAY SHALL NOT BE GREATER THAN 7.75". THE GREATEST RISER HEIGHT SHALL NOT EXCEED THE SMALLEST BY MORE THAN 3/4". THE RUN SHALL NOT BE LESS THAN 10". THE LARGEST RUN SHALL NOT

1.5 GPM (OR 1.8 GPM FOR KITCHEN FAUCETS).

EXCEED THE SMALLEST BY MORE THAN 3/8". THIS PROJECT-RISE = 7.75 INCHES AND RUN = 10 INCHES. RISERS ON STEPS SHALL NOT BE GREATER THAN 7.75" AND NO LESS THAN 4" HIGH. THE GREATEST RISER HEIGHT SHALL NOT EXCEED THE SMALLEST BY MORE THAN 3/8". THE RUN

SHALL NOT BE LESS THAN 10". THE LARGEST RUN SHALL NOT EXCEED THE SMALLEST BY MORE THAN 3/4". PROVIDE 36" MIN. DEEP LANDING AT EXTERIOR ACCESS. IF DOOR SWING IS OVER LANDING - PROVIDE 1/2" MAX. HEIGHT DIFFERNTIAL BETWEEN FIN. FLR. AND EXTERIOR LANDING.

PROPOSED 1ST FLOOR PLAN

RAILING NOTE: 42" HIGH GUARDRAIL WITH INTERMEDIATE RAILS SPACED SUCH THAT A SPHERE 4"~ CAN NOT PASS THROUGH. GUARDRAIL MUST RESIST A 20 plf HORIZ. LOAD (13) PERPENDICULAR TO THE TOP RAIL AND 25 psf HORIZ. LOAD PERPENDICULAR TO THE FILLER ELEMENTS. THE TOP OF THE GUARD SHALL BE NOT LESS THAN 34 INCHES AND NOT MORE THAN 38 INCHES AS MEASURED VERTICALLY FROM A

LINE CONNECTING THE LEADING EDGES OF THE TREADS.

ROOM EGRESS NOTE: EVERY SLEEPING ROOM BELOW THE FOURTH FLOOR SHALL HAVE @ LEAST ONE WINDOW OR EXTERIOR DOOR FOR EMERGENCY EXIT WHICH OPENS DIRECTLY ONTO A PUBLIC STREET, ALLEY, YARD OR (14) EXTERIOR COURT. THE DISTANCE FROM THE FLOOR TO THE BOTTOM OF THE CLEAR OPENING SHALL NOT TO EXCEED 44"

THE EGRESS OPENING SHALL HAVE A MIN. NET OPEN AREA OF 5.7 SQ.FT. (5.0SQ.FT. @ GRADE FLOOR LEVEL) W/ A MIN. 24" NET CLEAR OPENING HEIGHT & A MIN. 20" NET CLEAR OPENING WIDTH. (R310 CRC)"


(15) SHOWER & TUB NOTES:

A. TEMP. GLASS @SHOWER ENCLOSURE, DOOR, & ADJACENT WINDOWS. SHWR. DOOR SHALL NOT OPEN INTO THE SHOWER & BE A MIN. 22" WIDE. GLASS COLOR & FASTENERS TO BE DECIDED BY OWNER.


B. SHOWER SHALL BE PROVIDED W/ INDIVIDUAL CONTROL VALVES OF THE PRESSURE BALANCE OR THE THERMOSTATIC MIXING VALVE TYPE, PER CPC SEC. 408.3

C. SHOWER COMPARTMENTS SHALL HAVE A MIN. FINISHED INTERIOR OF 1024 SQUARE INCHES AND BE ABLE TO ENCOMPASS A 30" DIAMETER CIRCLE.

D. PROVIDE SMOOTH, HARD, NONABSORBENT SURFACE OVER A MOISTURE RESISTANT UNDERLAYMENT TO A HEIGHT OF 72" ABOVE THE DRAIN INLET. PLEASE NOTE: WATER-RESISTANT GYP. BACKING BD. SHALL NOT BE USED OVER A VAPOR RETARDER IN SHOWER OR BATHTUB COMPARTMENTS, CRC R307.2

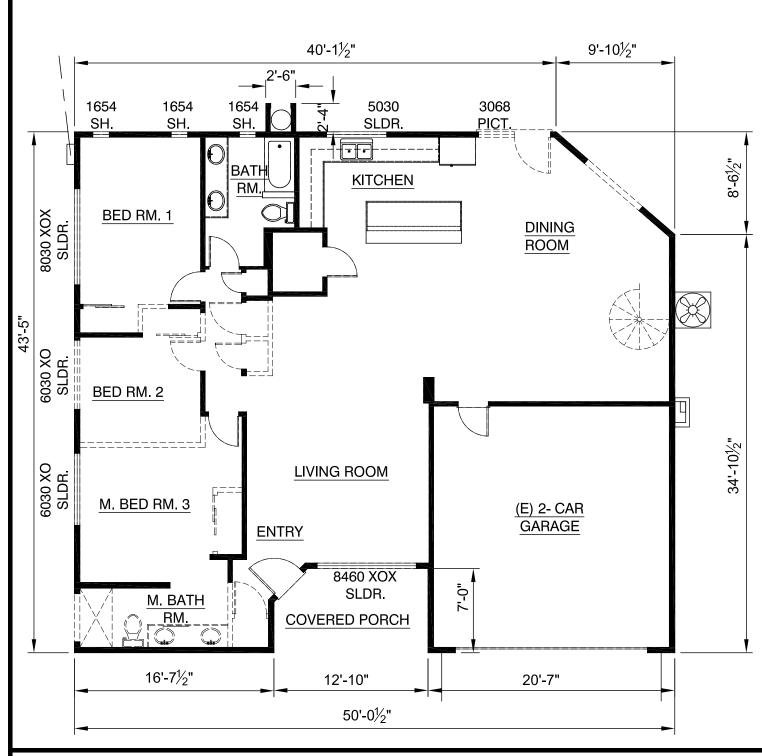

EXISTING 1ST FLOOR DEMO. PLAN SCALE: 1/8" = 1'-0"

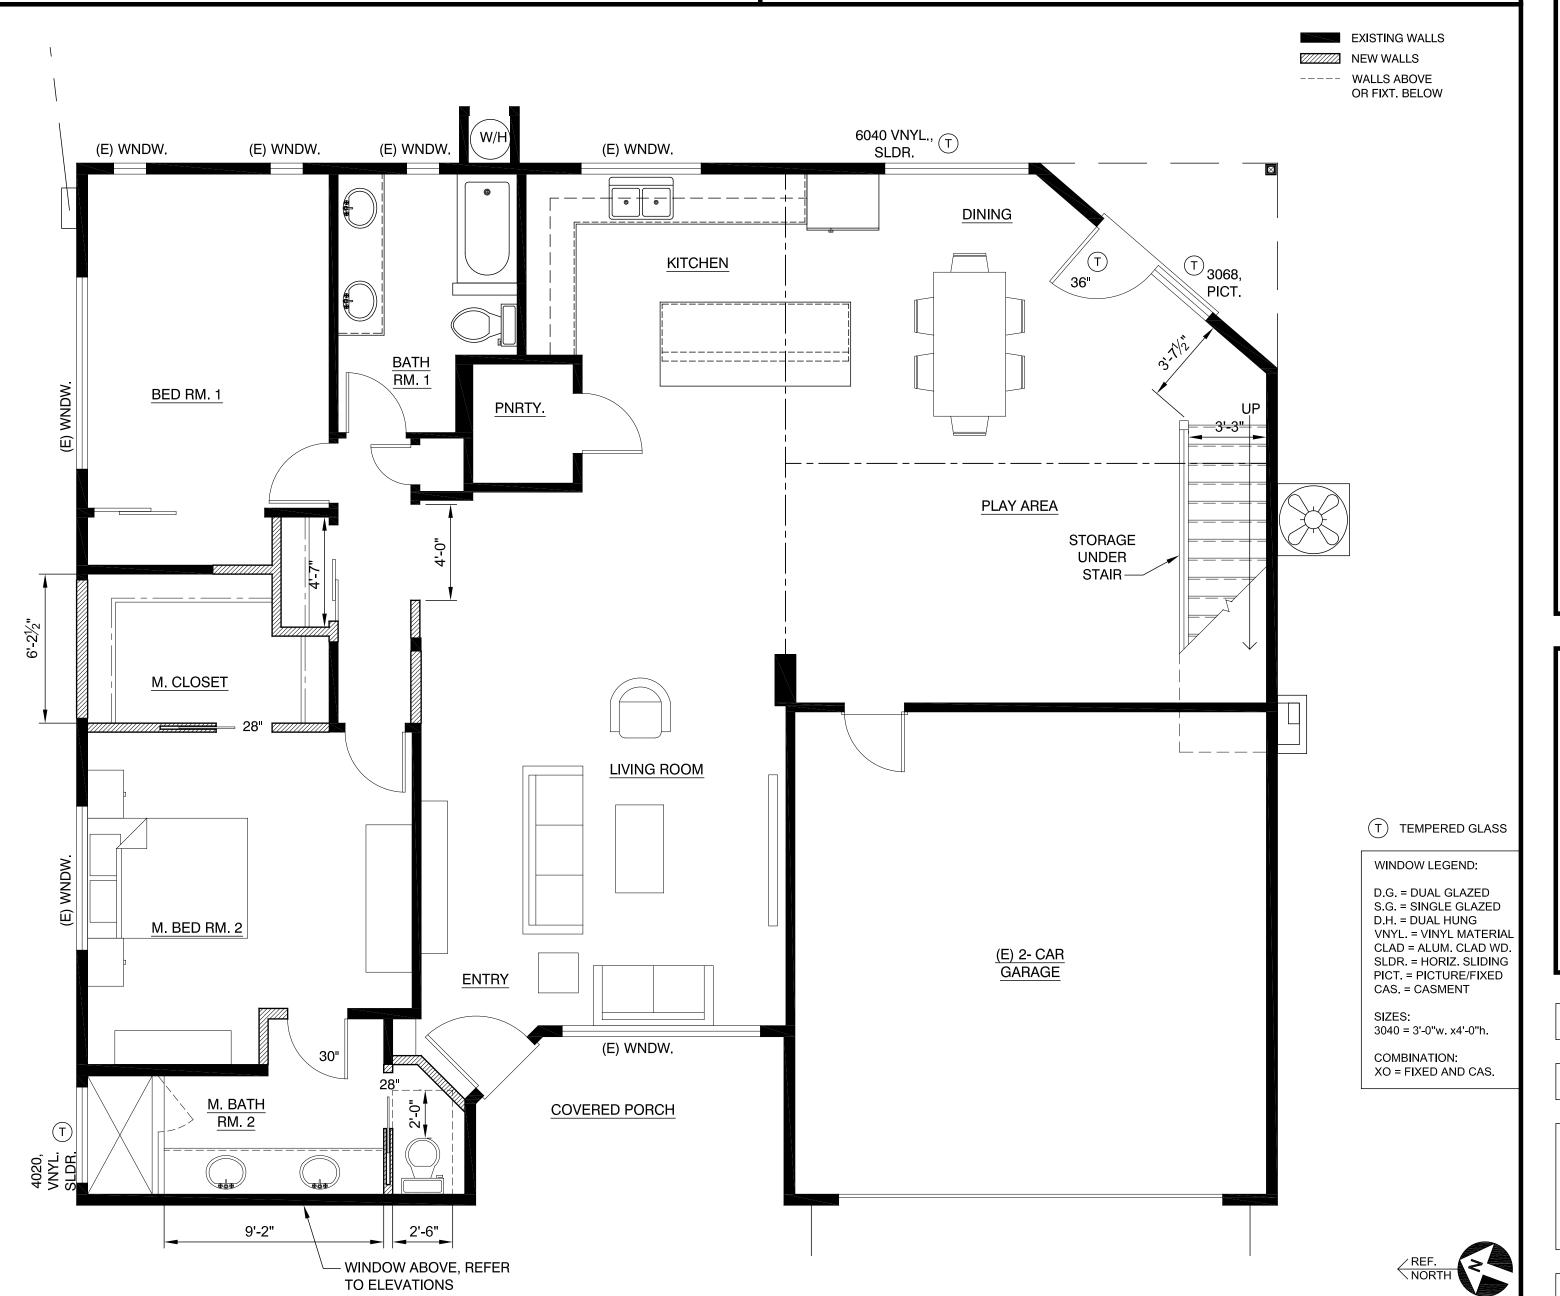

<u>plo</u> 0


OF Z HOME MODIFICATION **ං**ජ SE

DRAWN BY JOB NO. 2173-19 DATE: JULY 26, 2019

REVISIONS

SHEET NO. 2 OF: 5

SCALE: 1/4" = 1'-0"

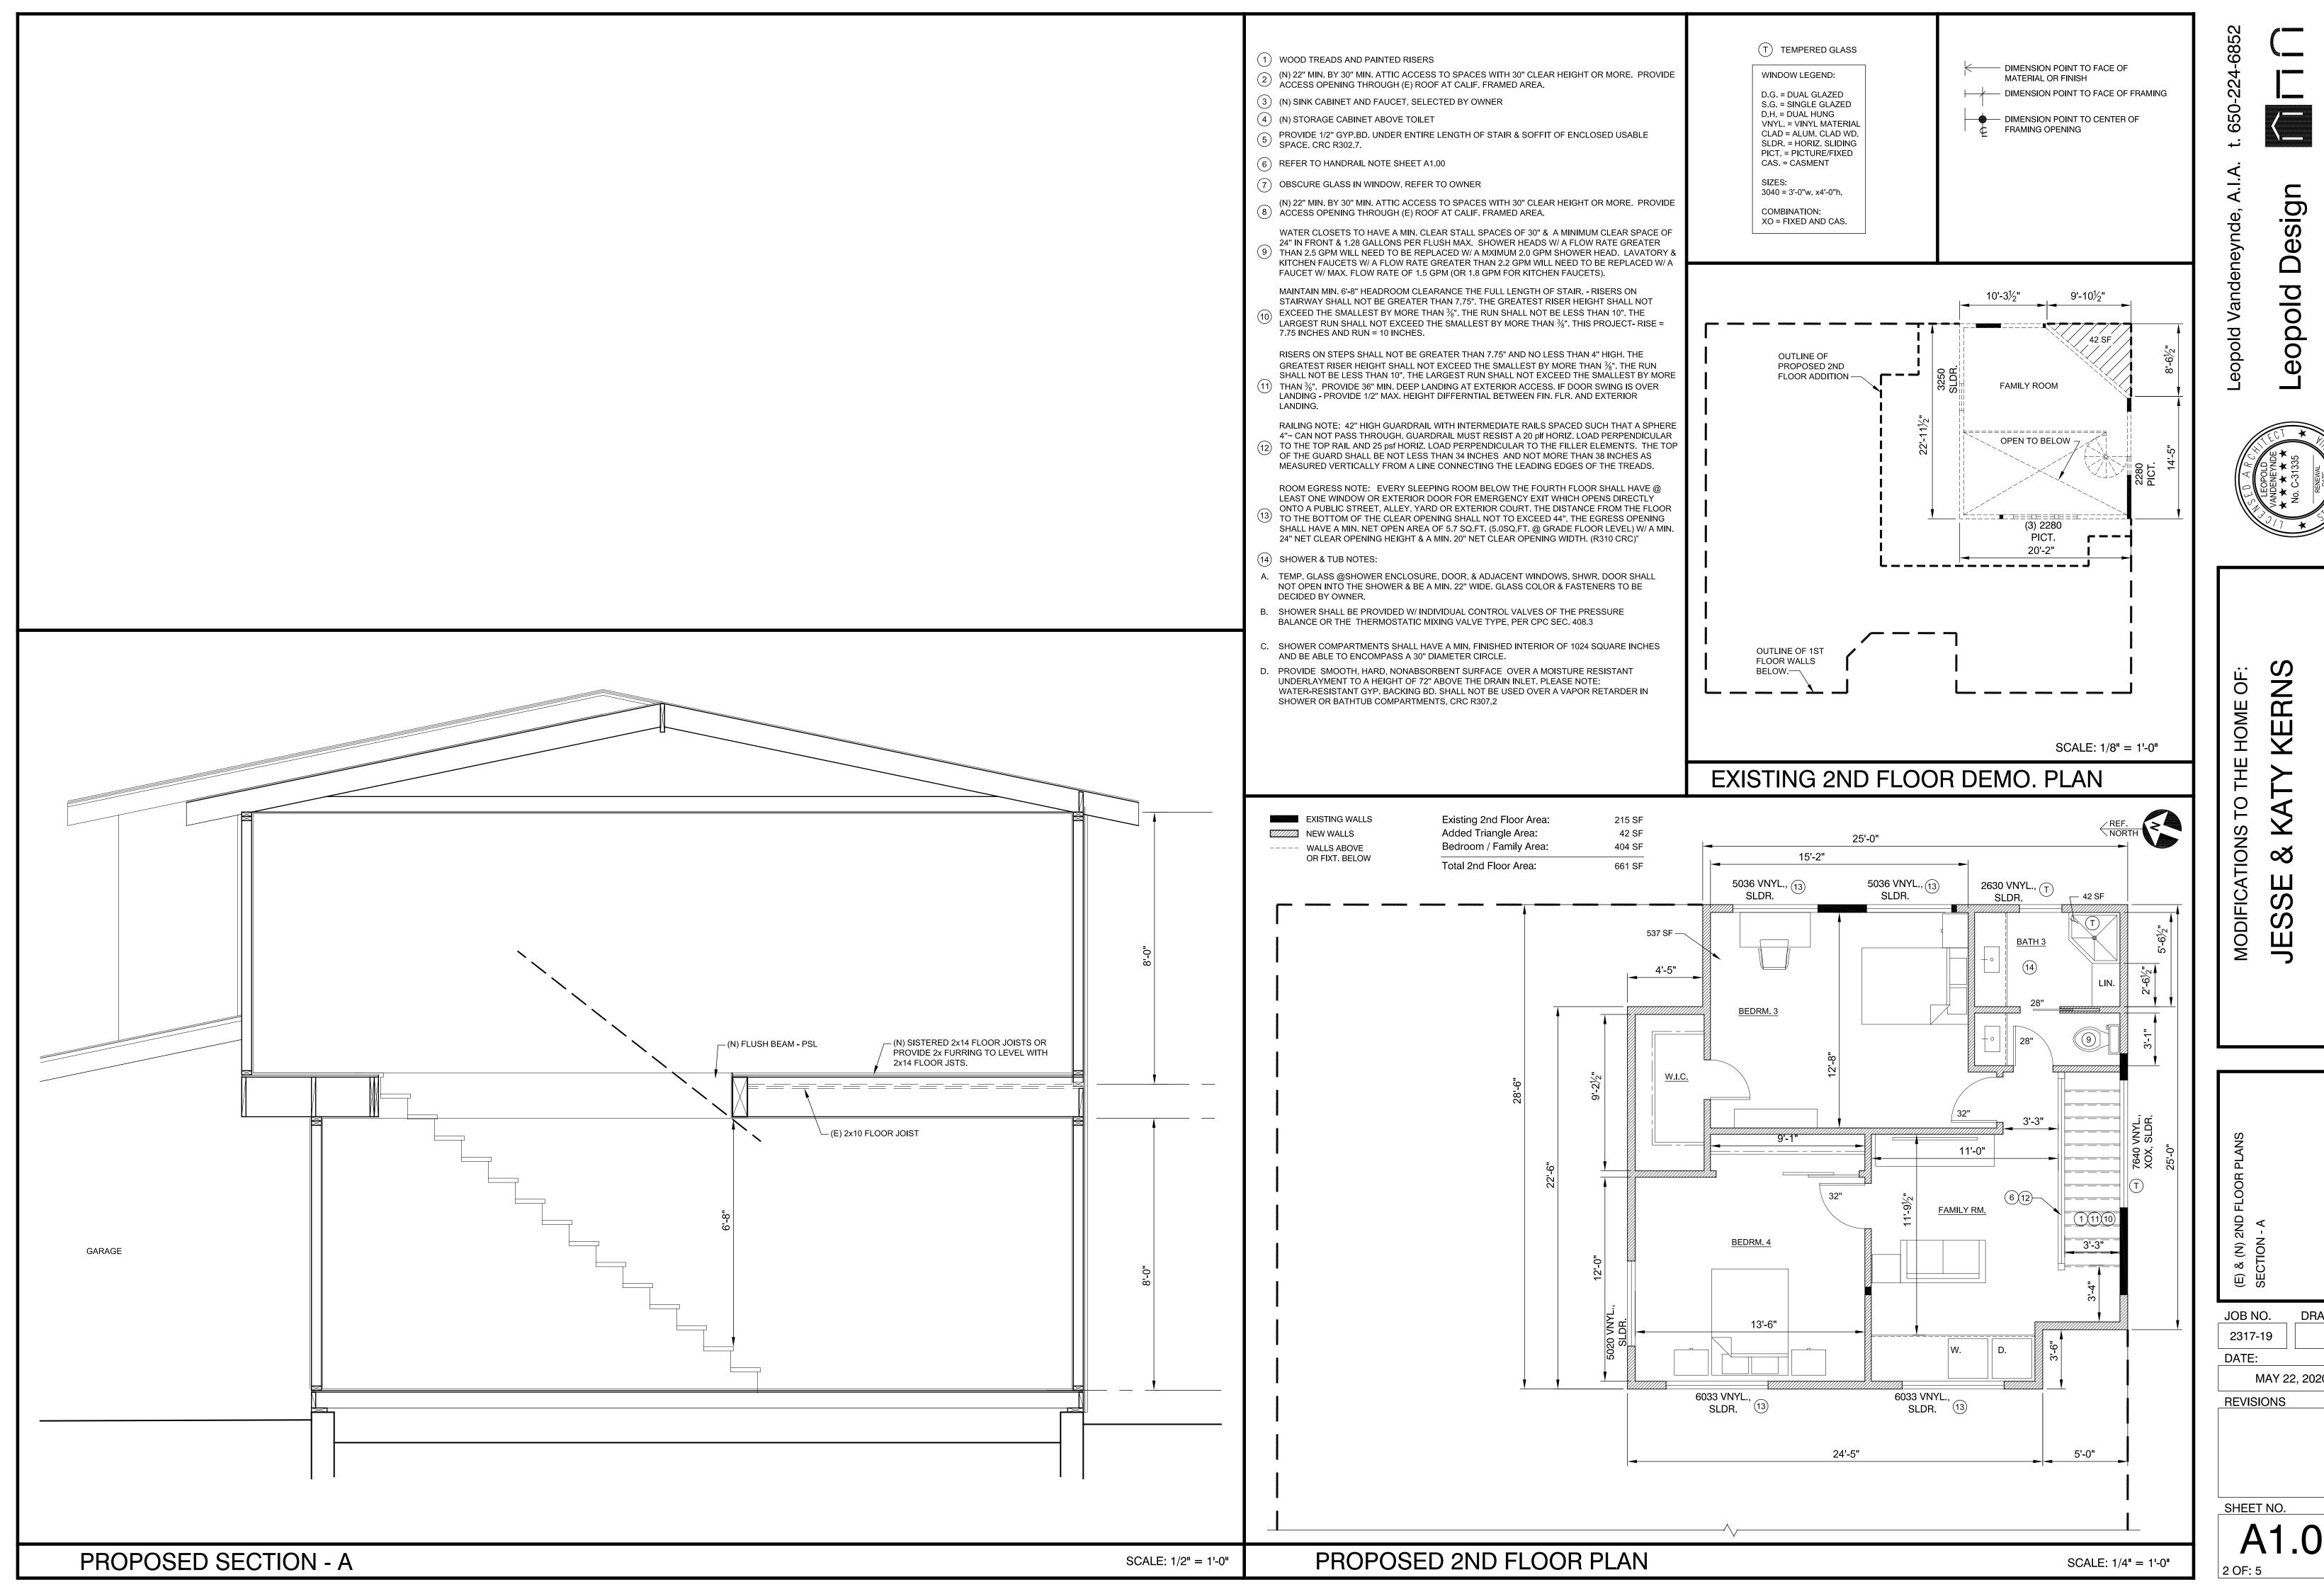

DRAWN BY MAY 22, 2020

