

DEVELOPMENT REVIEW HEARING PROJECT OVERVIEW

Meeting Date: October 21, 2020

File No.(s): PLN2020-14492

Location: **756 Baird Avenue,** a 6,100 square-foot site, located on the east side

of Baird Avenue, approximately 120 feet south of Clyde Avenue; APN:

101-23-022; property is zoned Single-Family Residential (R1-6L).

Applicant: Natalia Amatuni for Residential Design

Owner: Venu Thiruvengada

Request: Architectural Review of a 276 square-foot first-floor expansion and

756 square-foot second-story addition to an existing 1,778 square-foot three-bedroom and two-bathroom home, resulting in a 2,810 square-foot, six-bedroom and four-bathroom home including a 426 square-foot

two-car garage to remain.

Mailing Radius: 300 feet

CEQA Determination: Categorical Exemption per CEQA 15301(e)(1), Existing Facilities

Project Planner: Jeff Schwilk, Associate Planner Staff Recommendation: Approve, subject to conditions

Project Data

Lot Size : 6,100 sq. ft.			
	Existing Floor Area (sq. ft.)	Proposed Addition (sq. ft.)	Proposed Floor Area (sq.ft.)
First Floor	1,352	276	1,778
Second Floor	n/a	756	756
Porch covers	n/a	25	25
Garage	426		426
Sheds	120		120
Gross Floor Area	1,778		2,960
Lot Coverage	1,898/6,100 = 31%		2,349/6,100 = 38%
F.A.R.	1,778/6,100 = .29		2,960/6,100 = .49
% of 2 nd floor to 1 st floor	n/a		756/2,229 = 34%
Bedrooms/Baths	3/2	3/2	6/4
Flood Zone	X		X

Points for consideration

- The existing house was constructed in 1964 and located in the Bonnie Brae Tract.
- The house is bordered on all sides by similar existing single-story homes.
- The project includes the construction of a 276 square foot ground floor addition to the front of the
 existing house, and a 756 square foot second-floor addition above the rear ground floor area of
 the existing house.
- The project would increase the living area of the existing house by expanding the living room and kitchen areas to the front ground floor of the house and a new second floor addition with three new bedrooms and two bathrooms upstairs.
- The exterior of the addition would be clad in metal tile roofing to match the existing house roof, as well as stucco siding and vinyl windows to match the exterior materials of the existing house.

Development Review Hearing Address: 756 Baird Avenue October 21, 2020

Page 2

- Overall proposed building height is 22-feet, 6-inches, including 8-foot ceiling heights for the first and second floors.
- The proposal includes the addition of a 3-foot deep by 11-foot wide balcony off the south wall of the second-floor master bedroom.
- 300-foot neighborhood notice was distributed for this project review.
- There are no active code enforcement cases for this property.

Findings supporting the Staff Recommendation

- 1) That any off-street parking area, screening strips and other facilitates and improvements necessary to secure the purpose and intent of this title and the general plan of the City area a part of the proposed development, in that;
 - The proposal provides the required two covered parking spaces.
 - The required parking spaces are not located in the required front yard or side yard landscaped areas.
 - The proposed project provides areas surfaced with all-weather materials for parking of vehicles.
- 2) That the design and location of the proposed development and its relation to neighboring developments and traffic is such that it will not impair the desirability of investment or occupation in the neighborhood, will not unreasonably interfere with the use and enjoyment of neighboring developments, and will not create traffic congestion or hazard, in that;
 - The proposed house expansion resulting in three additional bedrooms and two additional bathrooms would not create traffic congestion or hazards.
 - Public streets are adequate in size and design to serve the proposed single-family residence, and the use will not create a substantive increase in traffic.
- 3) That the design and location of the proposed development is such that it is in keeping with the character of the neighborhood and is such as not to be detrimental to the harmonious development contemplated by this title and the general plan of the City, in that;
 - The proposed development is a two-story home that is consistent with the scale and design similar to the existing surrounding neighborhood.
- 4) That the granting of such approval will not, under the circumstances of the particular case, materially affect adversely the health, comfort or general welfare of persons residing or working in the neighborhood of said development, and will not be materially detrimental to the public welfare or injuries to property or improvements in said neighborhood, in that;
 - The project is subject to the California Building Code and City Code requirements, which serve to regulate new construction to protect public health, safety and general welfare.
- 5) That the proposed development, as set forth in the plans and drawings, are consistent with the set of more detailed policies and criteria for architectural review as approved and updated from time to time by the City Council, which set shall be maintained in the planning division office. The policies and criteria so approved shall be fully effective and operative to the same extent as if written into and made a part of this title, in that;
 - The project would create a house design that is compatible scale and character with the housing types that is consistent with the neighborhood.

Development Review Hearing Address: 756 Baird Avenue October 21, 2020

Page 3

Conditions of Approval:

- 1) Garage shall be maintained clear and free for vehicle parking use at all times. It shall not be used only for storage.
- 2) Submit plans for final architectural review to the Planning Division and obtain architectural approval prior to issuance of building permits. Said plans to include, but not be limited to: site plans, floor plans, elevations, landscaping, lighting and signage.
- 3) Landscaping installation shall meet City water conservation criteria in a manner acceptable to the Director of Community Development.
- 4) Maintain the front yard landscaping between the house and sidewalk. New landscape areas of 500 square feet or more or rehabilitated landscape areas of 2,500 square feet or more shall conform to the California Department of Water Resources Water Efficient Landscape Ordinance.
- 5) The applicant shall plant and maintain a street tree in the front yard.
- 6) Developer/Owner is responsible for collection and pick-up of all trash and debris on-site and adjacent public right-of-way.
- 7) Construction activity shall be limited to the hours of 7:00 a.m. to 6:00 p.m. weekdays and 9:00 a.m. to 6:00 p.m. Saturdays for projects within 300 feet of a residential use and shall not be allowed on recognized State and Federal holidays.
- 8) Incorporate Best Management Practices (BMPs) into construction plans and incorporate post construction water runoff measures into project plans in accordance with the City's Urban Runoff Pollution Prevention Program standards prior to the issuance of permits.

Attachments

1) Development Plans

PROJECT DATA

PROJECT NAME: THIRUVENGADA RESIDENCE
PROJECT ADDRESS: 756 BAIRD AVE, SANTA CLARA, CA, 95054
APN: 101-23-022 PROJECT TYPE: SECOND FLOOR ADDITION AND REMODELING
OWNER: VENU THIRLYENGADA 650 7666708

PLANS DRAWN BY: NATALIA AMATLINI 408 4200411

PROJECT SUMMARY

ZONNING: R1- 6L- SINGLE FAMILY LAND USE DESIGNATION: VERY LOW DENSITE RESIDENTIAL

TYPE OF CONSTRUCTION: V-B

OCCUPANCY GROUP: R3/ U

EXISTING BUILDING IS NOT EQUIPPED WITH AUTOMATIC SPRINKLER SYSTEM.

FLOOD ZONE: X

garage spaces: 2 GROSS LOT AREA: 6 098 sq.ft./0.14 ACRES

NET LOT AREA: 6 098 sq.ft./0.14 ACRES

(E) RESIDENCY WITHOUT THE GARAGE: 1352.00 SQ.FT. GARAGE: 426.0 SQ.FT. TOTAL EXISTING HOUSE WITH GARAGE: 1778.0 SQ.FT.

ADDITION: 1ST FLOOR: 276.00 SQ.FT.
2ND FLOOR 756.00 SQ.FT.
TOTAL ADDITION: 1032.00 SQ.FT.

PROPOSED HOUSE WITHOUT GARAGE: 2, 384.00 SQ, FT.
GARAGE: 426.00 SQ, FT.
PROPOSED HOUSE WITH GARAGE: 2, 910.00 SQ, FT.
(E) LOT COVERAGE: 1888 DIVIDED BY 9088-31%
PROPOSED LOT COVERAGE: (1628 + 426 + 120)-2174 DIVIDED BY 6098-35.6%
MIN. SETBACK FROM: 20

MIN. REAR SETBACK: 20' MAX HEIGHT: 25'

MAX HEIGHT: 25'
PROPOSED BULLIDING HEIGHT: 22-5'
BULLIDING COVERAGE INCL. ACCESSORY STRUCTURE: 40%
(Buldings, including accessory buildings, shall not cover a total of more than forty percent (40%) of the
(Buldings, including accessory buildings, shall not cover a total of more than forty percent (40%) of the
(Buldings, including accessory buildings, shall not cover a total of more than forty percent (40%) of the

ARX. LOT COVERAGE: 2438 00 SO.FT.

PARKING REQUIREMENTS: 4001 Q GARAGE 4 2 OPEN) 10720' EACH

18.12 808 Front yard Share
Each lot shall have a front yard not less than twenty (20) feet in depth. A minimum of thirty-five percent
(35%) of the front yard shall be permanently maintained as landscaped area. (Ord. 1680 § 3, 11-14-95;
Zoning Ord, § 6-7).

SEE A2 FOR FRONT LANDSCAPING AREA CALCULATIONS









SCOPE OF WORK

1032 SQ.FT. FIRST AND SECOND STORY ADDITIONS: 756 SQ.FT. SECOND STORY ADDITION TO PROVIDE THREE NEW BEDROOMS AND TWO NEW BATHROOMS. TO ADD A STAIR.

276 SQ.FT. FIRST FLOOR ADDITION TO ENLARGE KITCHEN AND LIVING ROOM

FLOOR AREA	EXISTING	PROPOSED
LIVING (CONDITIONED) AREA	ONE FLOOR: 1 352.00	1ST FL: 1 628.00 2ND FL: 756.00 TOTAL: 2 384.00
2-CAR GARAGE	426.00	426.00
2 ND DWELLING UNIT	N/A	N/A
ACCESSORY STRUCTURE	SHED 120.00	SHED 120.00
TOTAL WITHOUT GARAGE	1 352.00	2 384.00
TOTAL WITH GARAGE	1 778.00	2 810.00

PLANS SHALL BE IN COMPLIANCE WITH:

CALIFORNIA BUILDING CODE, 2019 EDITION

CALIFORNIA RESIDENTIAL CODE, 2019 EDITION

CALIFORNIA PLUMBING CODE, 2019 EDITION

CALIFORNIA MECHANICAL CODE, 2019 EDITION

CALIFORNIA ELECTRICAL CODE, 2019 EDITION


2019 CALIFORNIA REFERENCED STANDARDS CODE


2019 CALIFORNIA ENERGY CODE

2019 GREEN BUILDING CODE

2019 FIRE CODE

A1	PROJECT DATA	
A1.2	AREA CALCULATIONS, 3D MODELS	
A2	PLOT PLAN , LANDSCAPING AREA CALCS	
A3	EXISTING FLOOR PLANS & EXISTING ELEVATIONS	
A4	PROPOSED PLAN	
A5	PROPOSED ELEVATIONS	
A6	ROOF PLAN & GENERAL NOTES & 3D MODELS	
A7	SECTIONS	
A8	ELECTRICAL PLAN	
A9	CAL GREEN	
EN1	TITLE 24	
CG1	CAL GREEN CHECKLIST	
S1.0	GENERAL NOTES	
S1.1	SWS + DETAILS	
S1.2	HOLDOWN DETAILS	
S1.3	TYPICAL DETAILS	
S2.0	FOUNDATION & FIRST FRAMING PLAN	
S2.1	SHEAR-WALL PLAN	
S2.2	FDN & FRAMING DETAILS	
	ROOF & CLNG FRAMING PLAN	
S3.0		

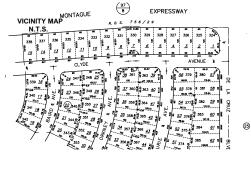

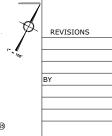

NOTES: NTRACTOR OR OWNER/ BUILDER IS RESPONSIBLE FOR VERIFICATION OF ALL SETBACKS, DIMENSIONS AND ROOF SLOPES IN FIELD.

EXISTING LANDSCAPING TO BE PROTECTED DURING CONSTRUCTION AND TO BE RETAINED AFTER CONSTRUCTION.

FINISH GRADE AROUND THE STRUCTURE SHALL SLOPE AWAY FROM THE FOUNDATION A MIN. OF 5% FOR A MIN. DISTANCE OF 10 FEET (CBC 1804.3).

ON GRADED SITES, THE TOP OF ANY EXTERIOR FOUNDATION SHALL EXTEND ABOVE THE ELEVATION OF THE STREET GUTTER ATA POINT OF DISCHATGE (OR THE INLET OF AN APPROVED DRAINAGE DEVICE). A MIN. 12 INCHES PLUS 2%.

NOTE 1: 2019 CALIFORNIA CODE OF REGULATIONS AS AMENDED BY STATE OF CALIFORNIA AND ALL APPLICABLE CITY OF SANTA CLARA ORDINANCES WILL BE EMPLOYED DURING THIS PROJECT.

NOTE 3: NO DEBRIS BOXES OR BUILDING MATERIALS SHALL BE STORED ON THE STREET.

NOTE 5: THERE WILL BE NO NEW LANDSCAPED AREA AS THE PART OF THIS PROJECT.

NOTE 6:PROVIDE TREE PROTECTION DURING CONSTRUCTION. THERE WILL BE NO TREES REMOVED.

NOTE 7: VERIFY LOCATION OF UNDERGROUND UTILITIES AND NOTIFY UTILITY COMPANY PRIOR TO DIGGING.

NOTE 8: IMPLEMENT REQUIRED MEASURES TO MINIMIZE STORM WATER RUN OFF FROM THE SITE AND PREVENT STORM WATER CONTAMINATION DURING CONSTRUCTION PROVIDE DRY WELLS UNDER EA. DOWNSPOUT

NOTE 9: PLUMB INTERIOR FLOOR DRAINS TO SANITARY SEWER

NOTE 10: PLUMB INTERIOR GARAGE FLOOR DRAINS TO SANITARY SEWER

NOTE 11: MARK ON-SITE INLETS WITH THE WORDS "NO DUMPING! FLOWS TO BAY

NOTE 12: PROVIDE ROOFED AND ENCLOSED AREA FOR DUMPSTERS , RECYCLING CONTAINERS, ETC. TO PREVENT STORMWATER RUN ON AND RUNOFF.

NOTE 13: COVER STORED OUTDOOR EQUIPMENT/ MATERIALS TO AVOID POLLUTANT CONTACT WITH STORMWATER RUNOFF.

NOTE 14: ROOF DRAINS SHALL DRAIN TO UNPAWED AREA WHEN PRACTICABLE. DRAIN BOILER DRAIN LINES, ROOF TOP EQUIPMENT, ALL WASHWATER TO SANITARY SEWER

NOTE 15: DIRECT ROOF RUNOFF ONTO VEGETABLE AREA

NOTE 16: DIRECT RUNOFF FROM SIDEWALKS, WALKWAYS AND/ OR PATIOS ONTO VEGETABLE AREA

THE STATE OF THE CONTROL OF THE STATE OF THE

NOTE 18: PROVIDE A COPY OF THE OPERATION AND MAINTENANCE MANUAL AT THE TIME OF FINAL INSPECTION PER CGBC 4.401.1 THE MANUAL SHALL INCLUDE ALL APPLICABLE ITEMS 1-10.

NOTE : ALL EXTERIOR LANDINGS ARE LOCATED MAX. 7.75 - IN BELOW THE DOORS THRESHOLD.

- Wastewater generated from the installation, cleaning, treating, and washing of the surface
 of copper features, including copper roof, shall be discharged to the sanitary sewers or
 landscaping or collect/haul off-site.
- All landscaping shall be maintained and shall be designed with efficient irrigation systems to reduce runoff, promote surface filtration, and minimize the use of fertilizers,

3. Broken existing sidewalks and curbs shall be repaired as directed by City engineer in the field.

4. Recycle and/ or salvage for reuse a minimum of 65% of the nonhazardous construction and demolition waste in accordance with Section 4.4082, 4.408.3 or 4.408.4, or meet a more stringent local construction and demolition waste management (it) ordinance per CGBC 4.408.1

Venu Thiruvengada 756 BAIRD AVE, SANTA CLARA, CA, 95054 PROJECT FOR


> n.amatuni@gmail.com 408 4200411 NATALIA AMATUNI RESIDENTIAL DESIGN


PROJECT NO.


DATE

A1 OF

SHEET NUMBER

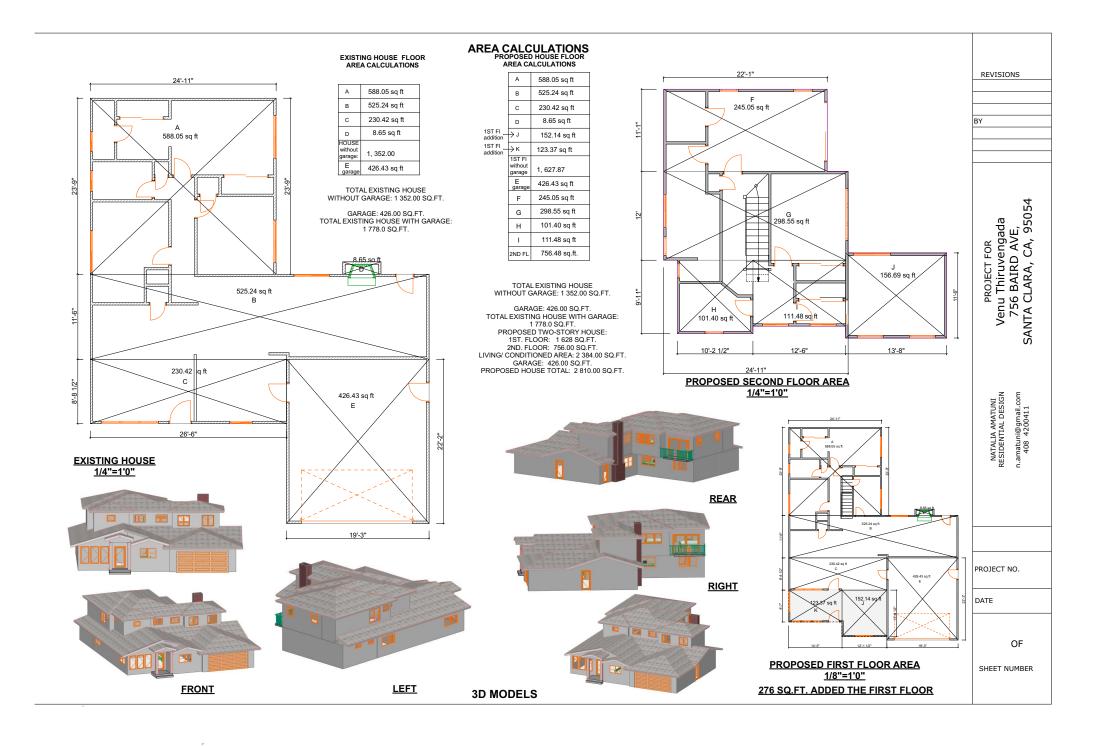

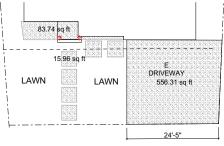

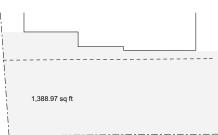

FRONT YARD: 1389 SQ.FT. LANDSCAPING AREA REQUIRED: 35%/: 486 SQ.FT. DRIVEWAY: 556 SQ.FT. (E) & (N) ENTRY CONC.: 84 SQ.FT. (E) CONC STEPS: 6X16=96 SQ.FT.

FRONT LANDSCAPING AREA CALCULATIONS 1/8"=1'0"

HANDRAILS


2016 CA. RESIDENTIAL CODE R311.7.8


R311.7.8 Handrails, Handrails shall be provided on not less than one side of each of

R311.7.8.2 Continuity. Handrails for stairways shall be continuous for the full length of the flight, from a poin

tirectly above the top riser of the flight to a point directly above the lowest riser of the flight. Handrail ends shall e returned or shall terminate in newel posts or safety terminals. Handrails adjacent a a wall shall have a space of not less than 11/2 inch (18 mm) between the wall and the

Exceptions:
(1) Handrails shall be permitted to be interrupted by a newel post at the turn. (2) The use of a volute, turnout, starting easing or starting newel shall be allow

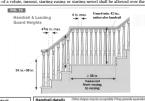

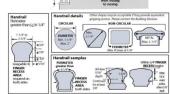

Storm water drainage and

PRO

)PERTY

LINE

100'

COCONUT

storm water orannage and retention during construction:

1. Provide 5% min. slope away from the building (6" for the first 10 feet.)


2. Cut swales at 1% slope min. to carry surface water to front yard landscaping. Refer to site plan to direction of drainage at swales. Swale elevation of high point to be 0.10' min, below pad elevation

In no case shall the swale flowline be lower than the bottom of the footing within 5' of the

than the bottom of the footing within 5' of the footing.

5. To prevent soil erosion during construction cover loose dirt with rolled occonut blankets or permeable geotexille fabric. Refer to manufacture recommended overlapping and stappling methods. If neccessary place straw wattles at the street property line to retain soil runoff on the site.

SITE PLAN LEGENT:

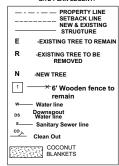

NOTE 3: ALL UNPAVED AREAS SHALL BE GRADED TO SLOPE AT 1% OR MORE. ALL PAVED AREAS SHALL BE GRADED TO SLOPE AT 0.5% OR MORE. ALL GRADING AND DRAINAGE WORK SHALL CONFORM TO THE CURRENT NPDES REQUIREMENTS. S.B.M.C. 12.16.020.

NOTE 1: PROVIDE WEEP SCREED AT THE BOTTOM OF STUCCO WALLS AT A LOCATION A MINIMUM OF 4" ABOVE EARTH OR 2" ABOVE PAVED AREAS PER CRC R703.6.2.1 NOTE 2: VENTS AT ROOF MUST BE A MINIMUM OF 3' ABOVE OF 10' HORIZONTALLY AWAY FROM OPERABLE SKYLIGHTS PER CPC 906.2

PLOT PLAN 1/8"=1'0"

PROPERTY LINE 67.30'

(E) SHED

TO

REMAIN

T = 24 = = = = = =

TWO-STORY

RESIDENCY

275,51 sq ft 1ST. FL.

6'13"-

FRONT SETBACK

LAWN

20'

ADDITION

PROPERTY LINE 55.92 SEWER

SIDEWALK

LAWN

12

9'-6"

125 AMP

SERVICE

SIDE SETBACK

Ε

SATE

PUE

SW.C.E.&P.U.E.

REAR SETBACK

FRUITTREES

Ε

CONC.

PATIO

TWO- CAR GARAGE

(E)

DRIVEWAY

20'

MAIN

BAIRD AVE

60' R.O.W.

24'-9"

2ND FL OVERHANG

E) DIRTO

100'

LINE

PROPERTY

SETBACK

SIDE

5'

ORANGE

-GAS

METER

WATER

METER

CURB

CUT

₩, E

GATE

It's Up to Us

General Business Practices





BEST MANAGEMENT PRACTICES FOR CONSTRUCTION INDUSTRY

Storm Drain Pollution from Fresh Concrete and Mortar Applications



It's Up to Us

Preventing Pollution: It's Up to Us



General Business Practice

Storm Drain Pollution from Construction Activities

Recycle/Reuse Leftover Paint

Venu Thiruvengada 756 BAIRD AVE, SANTA CLARA, CA, 95054 PROJECT FOR

REVISIONS


NATALIA AMATUNI RESIDENTIAL DESIGN


PROJECT NO.


DATE


A2 OF

SHEET NUMBER

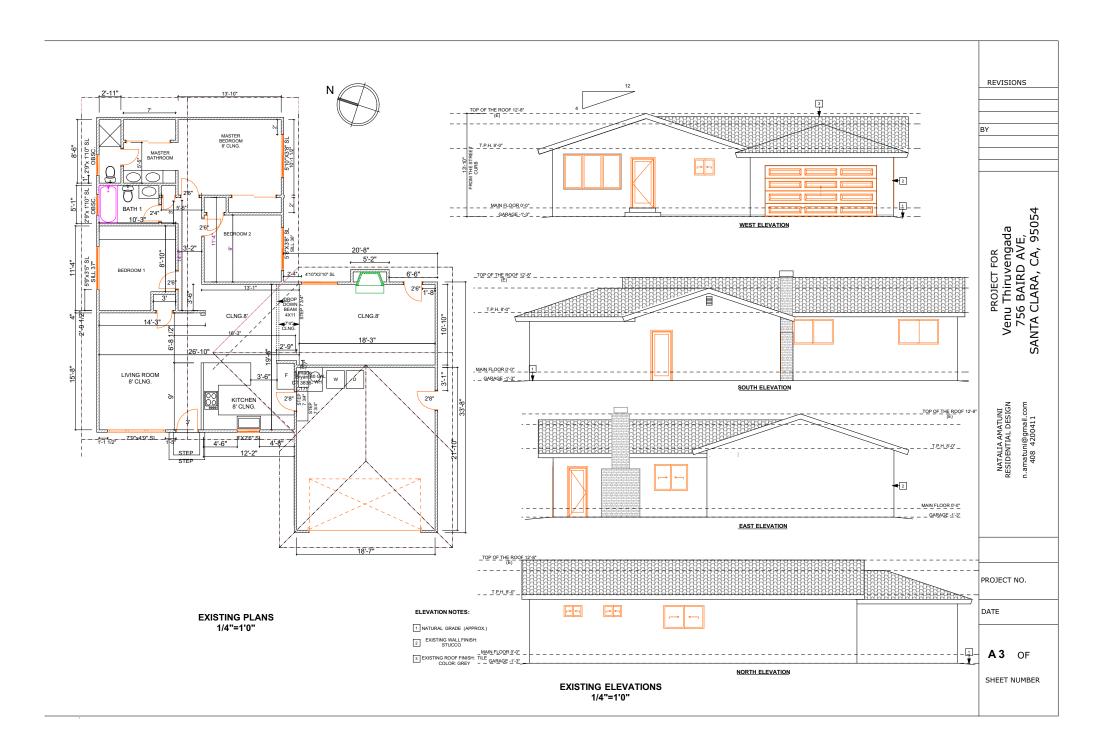

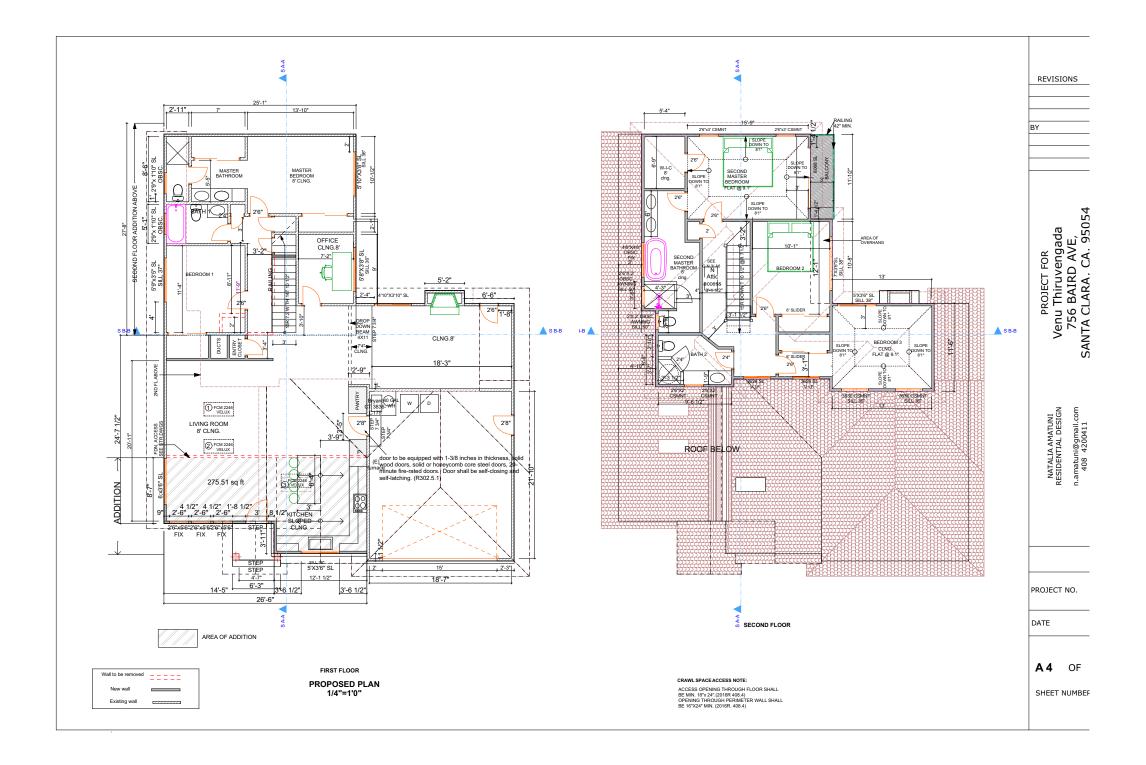

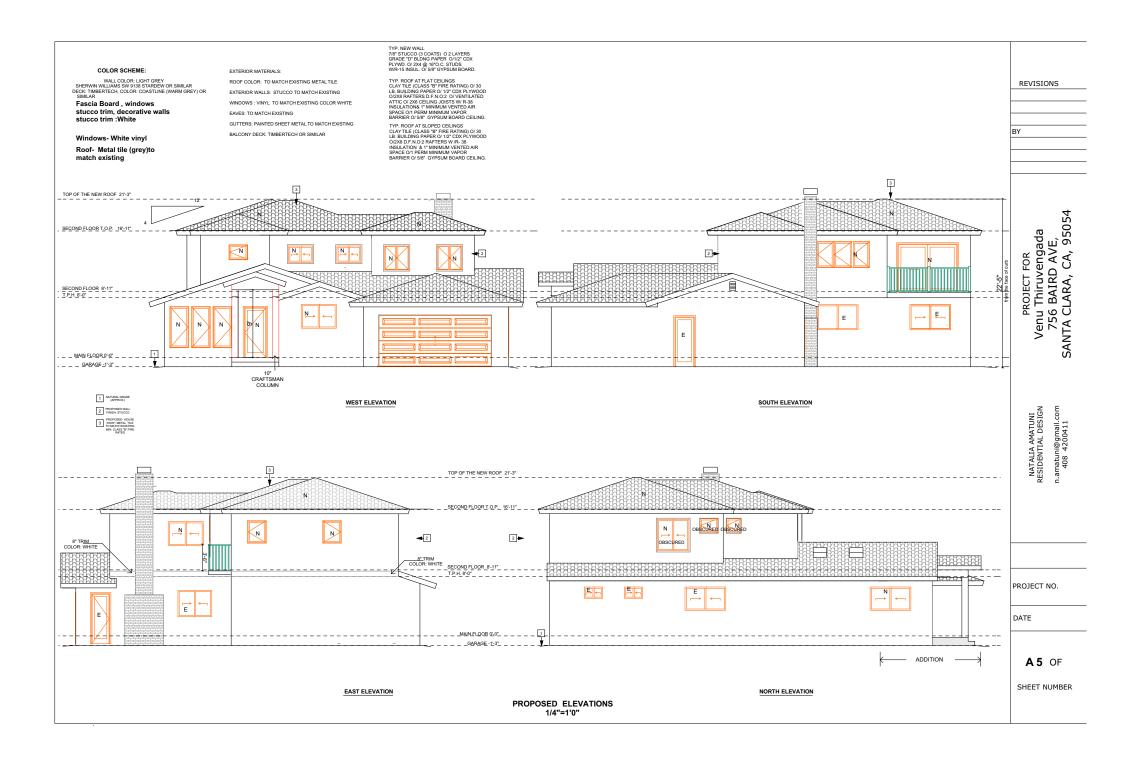

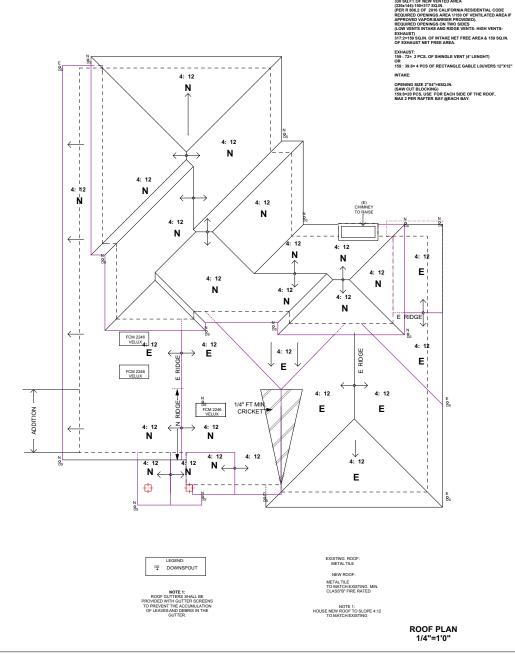

GENERAL NOTES

GENERAL NOTES

GENERAL CONTRACTOR AND ALL SIGNOCONTRACTORS SHALL MOTE FOR OR DESIGNER OF ANY DISCREPENCIES OR OMISSIONS FOUND IN THE DRAWINGS OR DESIGNER OF ANY DISCREPENCIES OR OMISSIONS FOUND IN THE DRAWINGS AND SPECIFICATIONS, OR BETWEEN THE DOCUMENTS AND EXISTING CONDITIONS PRIOR

VENTILATION

1. BATHROOMS AND LAUNDRY ROOMS WITHOUT NATURAL VENTILATION SHALL BE MECHANICALLY VENTILATED (S AIR CHANGES PER HOUR).
THE POINT OF DISCHARGE MUST BE MIN.3" ABOVE ANY BUILDING OPENINGS WITHIN 10".

330 SQ.FT.OF NEW VENTED AREA

ACCESS
2. PERFORE LINOISTRUCTED 18" MIN. BY 24" MIN. ACCESS TO ALL UNDERFLOOR SPACES WHERE JOISTS OR SUBFLOOR IS UNITREATED ORC RIGID.
2. PERFORE AREA OF VENTILATION OFENNAS SHALL NOT BE LESS THAN 11" 50 OF THE UNDER FLOOR AREA, SEE CRC RIGIS FOR EXCEPTIONS.
ACCESS OPENING PROJUCH FLOOR SHALL EE MIN. 15"22" (2018 R 408.4)
0. PENING THROUGH FOR TO ALL THE SHALL SHA

LANDING CORT LOOR IS REQUIRED AT EACH SIDE OF EACH EXTERIOR DOOR. THE WIDTH OF THE LANDING SHALL NOT BE LESS THAN THE DOOR WIDTH AND SYMMOM NO FEEL HANDING AT REVIEW BY A SHALL NOT BE LESS THAN THE OFFI HOR THE STRENGT HANDING AT REVIEW BE DOOR WIDTH AND SHALL NOT BE LESS THAN THE OFFI HOR THE STRENGT HANDING THAT IS NOT MORE THAN 7 3 AF LOWER THAN THE FLOOR LEYEL IF THE DOOR DOES NOT SWING INTO THE LANDING. CREATING THAT IS RETILED.

FIRE PROTECTION
5.ALL GARAGE CEILINGS, AND WALLS COMMON WITH LIVING AREA, OR SUPPORTING LIVING AREA ABOVE, TO BE 1 HOUR CONSTRUCTION.
6. IUSUBLE SPACE UNDER STAIR TO BE 1 HOUR CONSTRUCTION 56" TYPE" X" GYPSIUM BOARD MINIMUM AT ALL WALLS AND CEILING.
7. PROVIDE 6" MIN. CLEARANCE AT THE BACK OF FURNACE AND 12" TOTAL CLEARANCE ON SDES OF FURNACE.

STUCCO AT ALL HORIZONTAL SURFACES AND THE FIRST 12" VERTICAL PORTIONS AROUND CORNERS AND EDGES SHALL BE MIXED WITH "ACRYLE-80".
BELOW THE FOUNDATION PLATE LINE ON ALL EXTERIOR STUD WALLS WITH STUCCO. THE SCREED SHALL BE PLACED AT MINMAM OF PLADOR.
BELOW THE FOUNDATION PLATE LINE ON ALL EXTERIOR STUD WALLS WITH STUCCO. THE SCREED SHALL BE PLACED AT MINMAM OF PLADOR.
BELOW THE FOUNDATION PLATE LINE ON ALL EXTERIOR STUD WALLS WITH STUCCO. THE SCREED SHALL BE PLACED AT MINMAM OF PLADOR.
BELOW THE FOUNDATION PLANDERS SHALL BE OF A THE THAT WILL ALLOW THAT PRAPED WATER TO PRORN TO THE EXTERIOR OF THE BUILDING. SEC

APPLICATION OF STUCCO: STUCCO SHALL BE THREE COATS PROCESS AND 7/8" THICK OVER TWO LAYERS OF GRADE D WALLPAPER BACKED WITH METAL LATH.

ENERGY

ALL EXTERIOR DOORS TO BE 1 3/8" SOLID CORE AND WEATHER-STRIPPED.

DOOR FROM GARAGE TO HOUSE TO BE 1 3/8" SOLID CORE, WEATHER STRIPPED AND WITH SELF- CLOSING DEVICE.

ADD A BEAD OF CAULKING AROUND THE INTERIOR OF THE SOLE PLATE AT ALL EXTERIOR WALLS. THE BEAD SHALL BE APPLIED AT THE JOINT OF SUBFLOOR AND SOLE PLATE JUST PRIOR TO SHEETROCK APPLICATION.

SHOMER AND TUB SHOWER WALLS SHALL HAVE A SMOOTH, HARD, NONABSORBENT SURFACE (E.G., CERAMIC TILE OR FIBERCIASS) OVER A MOISTURE RESISTANT UNDERLAYMENT (E.G., CEMENT, FIBER CEMENT, OR GLASS MAT GYPSUM BACKER) TO A HEIGHT OF 72 NO-HEIGH OF 72 NO-HEIGHT OF

WHEN INSULATED SPACE IS SMALLER THAT 12" USE ROGOD INSULATION BOARD TO ALLPW MIT 1" AIRFLOW. WHEN INSULATING CEILINGS PROVIDE MIN. 1" SPACE EAR AIRFLOW.

PROVIDE CROSS VENTILATION AT ALL ROOFS.
CHECK MOISTURE CONTENT OF BUILDING MATERIALS USED IN WALL AND FRAMING BEFORE ENCLOSURE (4.505.3)

EACH BATHROOM SHALL BE MECHANICALLY VENTILATED WITH AN ENERGY STAR EXHAUST FAN, AND FAN MUST BE CONTROLLED BY HUMIDITY CONTROL (4.506.1)

PROVIDE 6" CLEARANCE ON COMBUSTION AIR SIDE OF FURNACE ROOM AND 30" WORKING SPACE IN FRONT OF ALL HEATING CONTROLS PER C.M.C.

PROVIDE MIN. REQUIRED DISTANCE OF TERMINATION OF VENTS, AND FILIES PER C.M.C. AND C.P.C. LATEST EDITION

IN A CASE OF MEMBRANE PENETRATION BY DUCT OR PIPE, PROVIDE 26 GA FOR MIN. 2' OF THE PENETRATION SECTION, PIPE SHALL BE METAL AT THE PENETRATION, ALL PENETRATION AREA SHALL BE CAULKED AND SEALED.

THE DRYFR DUCT RUN AND TERMINATION POINT OF THE DRYFR EXHAUST SHALL EXTEND TO THE OUTSIDE

TERMINATION OF ALL ENVIRONMENTAL AIR DUCTS SHALL BE A MINIMUM OF 3 FEET FROM ANY OPENINGS INTO THE BUILDING (I.E., DRYERS, BATH AND UTILITY FANS, ETC., MUST BE 3 FEET AWAY FROM DOORS, WINDOWS, ATTIC VENTS, OPENING SKYLIGHTS).

PER EPA REQUIREMENTS AND AS ENFORCED BY CONTRACTOR'S STATE LICENSE BOARD ANY CONTRACTOR WORKING IN A HOME THAT WAS BUILT PRIOR TO 1978 MUST BE SERTIFIED IN LEAD-SAFE WORK PRACTICES.

DUCT PENETRATING THE WALL OR CEILING SEPARATING THE DWELLING FROM THE GARAGE SHALL BE CONSTRUCTED OF A MINIMUM 26 GAGE SHEET STEEL OR OTHER APPROVED MATERIAL AND SHALL HAVE NO OPENING INTO THE GARAGE. CRC R302.5.2

PLUMBING

PROVIDE ANTI- SCALD SHOWER VALVES AT ALL NEW SHOWERS AND TUB/ SHOWERS.

SHOWER AND TUB/ SHOWER COMBINATIONS SHALL BE PROVIDED WITH INDIVIDUAL CONTROL VALVES OF THE PRESSURE BALANCE OR THERMOSTATIC MIXING VALVE TYPE.

THE WATER HEATER SHALL BE SESMIC STRAPPED OR ANCHORED IN ACCORDANCE WITH CPC 597.2 THE WATER HEATER SHALL BE LOCATED ON AN 16" PLATFORM, ABOVE THE FLOOR, UNLESS LISTED AS FLAMMABLE VAPOR IGNITION RESISTANT PER CPC 597.3

FI FCTRICAL

KITCHENS AND BATHROOMS ARE TO HAVE THEIR TITLE 24 FLUORESCENT FIXTURES OPERATED BY FIRST SWITCH AT ALL ENRANCES TO THE ROOMS. GENERAL LIGHTING FIXTURES ARE TO BE LOCATED SO AS TO ILLUMINATE FLOOR AND COUNTERS.

All bathrooms exhaust fans to be minimum 50 cfm intermittent airflow or provide 20 cfm for the continuously operating Bathroom exhaust fans.

FINISH NOTES:

USE HARDWOOD FLOOR IN THE KITCHEN & LIVING ROOM.
 TILE FLOOR IN THE BATHROOMS.
 ANY TRIM SPANNING A CORNER OR TWO ADJUSENT SURFACES SHOULD BE FASTENED ON ONE SIDE ONLY.

4. PROVIDE NON-SLIP FLOORING IN ALL AREAS, AND SLIP- RESISTANT WHEN WET IN BATHROOMS, ENTRY HALL AND KITCHEN.

BATHROOM FINISH:
a) BATHROOMS SHALL BE FINISHED WITH NONABSORBENT SURFACES EXTENDING TO A HEIGHT OF NOT LESS THAN 6 FEET ABOVE THE FLOOR.

B) WATER RESISTANT GYPSUM BACKING SHALLL NOT BE USED WHERE

TO WATER OR IN AREAS SUBJECT

CONTINUOUS HIGH HUMIDITY. CRC R702.3.8.1

5. TRESHOLDS AND FLOORING TRANSITION STRIPS TO MEET CBC CHAPTER 11A, EXCEPT EXTERIOR DOORS FLOOR LEVEL SHALL

6. DO NOT BUTT DISSIMILAR MATERIALS TIGHTLY, LEAVE REASONOBLE CLEARANCES @ JOINTS, TO ALLOW EXPANSION AND CONTRACTION, AND FOR DIFFERENT SETTLEMENT.

PROJECT FOR Venu Thiruvengada 756 BAIRD AVE, SANTA CLARA, CA, 95054

REVISIONS

n.amatuni@gmail.com 408 4200411

PROJECT NO.

DATE

A6 OF

SHEET NUMBER

